

## City of Dearborn

## INVITATION TO BID (ITB) FOR Comfort Station at Ford Field

CONTROL No. 123560A ADDENDUM No. 3

ISSUE DATE: 04/04/17

DUE DATE: 04/12/17 AT 3:00 PM Eastern Time

This addendum is being issued to modify some sections of the ITB, as well as to answer the last of the questions submitted by the question deadline.

## **MODIFICATIONS:**

Refer to the attached submitted from NSA:

Attachment 1-

- o Addendum No. 3 (2 pages)
- o Table of Contents (2 pages)
- Section 237333.16 Indoor, Indirect-fired Heating and Ventilating Units (3 pages)
- Section 238239.19 Wall and Ceiling Unit Heaters (2 pages)
  - Attachment 2-
- o Drawing E1.0
- o Drawing E3.0
- o Drawing M1.0
- o Drawing P1.0

## **ANSWERS TO SUBMITTED QUESTIONS:**

- 1. Does the city pay for the cost of the 3rd party inspections, namely, the inspection for an independent testing agency for concrete construction, masonry construction, steel construction, and soil inspection?
  - A: Due to the very tight timeline for completion of this project, the City of Dearborn prefers that the contractor secure and include the cost for all required 3<sup>rd</sup> party inspections. However, please note that the City of Dearborn retains the right to review and approve the testing agency(s) secured by the contractor.
- 2. Is the DECO Utility Meter to be located on the northeast interior wall rm # 103 per plan. or is it to be located on exterior wall ?
  - A: The DECO Utility Meter can be installed on the interior wall, as long as, there is a smart digital meter installed on the exterior wall to facilitate DTE and City staff outside meter reading access. If a smart digital meter cannot be used, the DECO Utility Meter should be installed on the interior wall.
- 3. Are there any provisions for Communications? (Telephone) No Details on site plan.
  - A: Yes, provisions are to be made to accommodate a ½" conduit run for a CAT5 communications/data line and one (1) dedicated phone line. NSA and the City of Dearborn's MIS Department will provide additional drawing specifications/notes to designate the exact installation location and confirm the materials to be utilized

THIS ADDENDUM MUST BE ACKNOWLEDGED ON THE RESPONSE FORM IN THE ITB



## ADDENDUM NO. 3

Dearborn Folrd Field Comfort Station NSA Project No. 215062.01 04/03/2017 page 1 of 2

#### **MODIFICATIONS DURING BIDDING**

This Addendum describes revisions to the Issued for Bid Documents issued February 27, 2017.

**ACCOMPANYING DOCUMENTS:** The following documents accompany this write-up and are a part of this Addendum and are dated April 3, 2017:

- Project Manual Documents: Section 000005 Table of Contents; Section 237333.16 Indoor, Indirect-Fired Heating and Ventilating Units; Section 238239.19 Wall and Ceiling Unit Heaters.
- Whole Drawings: M1.0; P1.0; E1.0; E3.0.
- Additional Documentation: None.

## Project Manual Documentation:

- ITEM NO. 1 Refer to Section 000005 Table of Contents (Reissued)
  - a. Sections added and deleted.
- ITEM NO. 2 Refer to Section 237333.16 Indoor, Indirect-Fired Heating and Ventilating Units (Issued)
  - a. Section added.
- ITEM NO. 3 Refer to Section 237339 Indoor, Direct-Fired Heating and Ventilating 100% Outside Air Units (Not issued)
  - a. Section deleted.
- ITEM NO. 4 Refer to Section 238239.19 Wall and Ceiling Unit Heaters (Issued)
  - a. Section added.

## Whole Drawings

- ITEM NO. 1 Refer to M1.0
  - a. Separated one exhaust fan into two exhaust fans for controllability.
  - b. Added electric ceiling heaters.
  - c. Added louvers above toilet room doors.
  - d. Changed HV-1 to F-1, and updated schedules accordingly.
  - e. Updated CFM's and duct-layout to accommodate design changes.
- ITEM NO.2 Refer to P1.0
  - a. Revised additional gas pipe sizes for clarification.
- ITEM NO.3 Refer to E1.0
  - a. Revised Panel Schedule RP-A to accommodate design changes.

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Project No. 215062.01 4/3/2017

ITEM NO.4 Refer to E3.0

- a. Revised branch circuit wiring to mechanical equipment to accommodate design changes.
- b. Indicated wire sizing to 100A special purpose receptacle at Utility Room 103 for clarification.

**END OF ADDENDUM WRITE-UP** 

Prepared by:

NORDSTRÓM SAMSON ASSOCIATES

Project Manager

## **Table of Contents**

000001	Title Page

000005 Table of Contents; Document Set

## **BIDDING REQUIREMENTS**

Provided by the City of Dearborn

#### **CONDITIONS OF CONTRACT**

Provided by the City of Dearborn

## **SPECIFICATIONS**

SECT.

NO. SECTION TITLE

#### **DIVISION 01 – GENERAL REQUIREMENTS**

Provided by the City of Dearborn

## **DIVISION 02 – EXISTING CONDITIONS**

024116 Structure Demolition

#### **DIVISION 03 – CONCRETE**

033000 Cast-In-Place Concrete

#### **DIVISION 04 - MASONRY**

042200 Concrete Unit Masonry 042300 Glass Unit Masonry

#### **DIVISION 05 - METALS**

051200 Structural Steel Framing 055000 Metal Fabrications

## <u>DIVISION 06 – WOOD, PLASTICS, AND</u> COMPOSITES

061053 Miscellaneous Rough Carpentry 061600 Sheathing

061753 Shop-Fabricated Wood Trusses

## <u>DIVISION 07 – THERMAL AND MOISTURE</u> <u>PROTECTION</u>

072100 Thermal Insulation

072119 Foamed In-Place Insulation

072500 Weather Barriers

073113 Asphalt Shingles

074616 Aluminum Siding

074633 Plastic Siding

074646 Fiber-Cement Siding

076200 Sheet Metal Flashing and Trim

079200 Joint Sealants

## **DIVISION 08 – OPENINGS**

081113 Hollow Metal Doors and Frames083113 Access Doors and Frames

083323 Overhead Coiling Doors

087100 Door Hardware

089119 Fixed Louvers

## **DIVISION 09 - FINISHES**

092900 Gypsum Board099113 Exterior Painting099123 Interior Painting

### **DIVISION 10 - SPECIALTIES**

101423 Panel Signage

102113.19 Plastic Toilet Compartments

102213 Wire Mesh Partitions

102800 Toilet, Bath, and Laundry Accessories

104416 Fire Extinguishers

#### **DIVISION 22 – PLUMBING**

220500 Common Work Results for Plumbing220523 General-Duty Valves for Plumbing Piping

220529 Hangers and Supports for Plumbing Piping and Equipment

220553 Identification for Plumbing Piping and Equipment

220700 Plumbing Insulation

221116 Domestic Water Piping

221119 Domestic Water Piping Specialties

221316 Sanitary Waste and Vent Piping

221319 Sanitary Waste Piping Specialties

223400 Fuel-Fired, Domestic-Water Heaters

224000 Plumbing Fixtures

## <u>DIVISION 23 – HEATING VENTILATING AND AIR</u> CONDITIONING

230500 Common Work Results for HVAC

230513 Common Motor Requirements for HVAC Equipment

230529 Hangers and Supports for HVAC Piping and Equipment

230553 Identification for HVAC Piping and Equipment

230593 Testing, Adjusting, and Balancing for HVAC

230700 HVAC Insulation

231123 Facility Natural-Gas Piping

233113 Metal Ducts

233300 Air Duct Accessories

233400 HVAC Fans

233713 Diffusers, Registers, and Grilles

235100 Breechings, Chimneys, and Stacks **237333.16 Indoor, Indirect-Fired Heating and** 

**Ventilating Units** 

## NSA ARCHITECTS, ENGINEERS, PLANNERS Project No. 215062.00

237339 Indoor, Direct-Fired Heating and Ventilating 100% Outside Air Units

238239.19 Wall and Ceiling Unit Heaters

#### **DIVISION 26 - ELECTRICAL**

260500	Common Work Results for Electrical
260526	Grounding and Bonding for Electrical Systems
260529	Hangers and Supports for Electrical Systems
260533	Raceways and Boxes for Electrical Systems
260544	Sleeves and Sleeve Seals for Electrical
	Raceways and Cabling
260553	Identification for Electrical Systems
260923	Lighting-Control Devices
262416	Panelboards
262726	Wiring Devices
265119	Led Interior Lighting

## **DIVISION 31 – EARTHWORK**

311000 Site Clearing 312000 Earth Moving

## **DIVISION 32 – EXTERIOR IMPROVEMENTS**

321313 Concrete Paving 329200 Turf and Grasses

## **DIVISION 33 – UTILITIES**

330500 Common Work Results for Utilities

## **DOCUMENT SET**

<u>The Contract Drawings</u> that accompany this Project Manual and with it form the Document Set are identified by the same Architect Project No. as this Project Manual. The individual drawings are listed on the Drawing Cover Sheet.

<u>Verification of Document Set</u>: Verify that the Document Set transmitted is complete. Compare Drawings received with lists. Documents in the Project Manual, except standard pre-printed Documents, are terminated with "END OF ..." statement.

<u>The Document Set</u> will include additional Documents, if any, that are issued in conjunction with addenda and bulletins.

END OF TABLE OF CONTENTS

# SECTION 237333.16 - INDOOR, INDIRECT-FIRED HEATING AND VENTILATING UNITS

## **PART 1 - GENERAL**

#### 1.1 SUMMARY

A. Section includes indoor, indirect-fired heating and ventilating units.

#### 1.2 ACTION SUBMITTALS

- A. Product Data: For each type and configuration of indoor, direct-fired heating and ventilating unit.
- B. Shop Drawings: For each type and configuration of indoor, direct-fired heating and ventilating unit.
  - 1. Include plans, elevations, sections, and details.
  - 2. Include details of equipment assemblies. Indicate dimensions, weights, loads, required clearances, method of field assembly, components, and location and size of each field connection.

## 1.3 INFORMATIONAL SUBMITTALS

- A. Sample Warranty: For manufacturer's special warranty.
- B. Seismic Qualification Certificates: For indoor, direct-fired heating and ventilating units, accessories, and components, from manufacturer.

#### 1.4 CLOSEOUT SUBMITTALS

A. Operation and maintenance data.

## 1.5 QUALITY ASSURANCE

- A. Comply with NFPA 70.
- B. ASHRAE Compliance: Applicable requirements in ASHRAE 62.1, Section 5 "Systems and Equipment" and Section 7 "Construction and Startup."
- C. ASHRAE/IES 90.1 Compliance: Applicable requirements in ASHRAE/IES 90.1, Section 6 "Heating, Ventilating, and Air-Conditioning."

#### 1.6 WARRANTY

A. Special Warranty: Manufacturer agrees to repair or replace components of direct-fired heating and ventilating units that fail in materials or workmanship within specified warranty period.

1. Warranty Period for Heat Exchangers: Manufacturer's standard, but not less than 10 years from date of Substantial Completion.

## **PART 2 - PRODUCTS**

## 2.1 MANUFACTURERS

- A. Manufacturers: Subject to compliance with requirements, provide products by one of the following:
  - 1. Greenheck Fan Corporation.
  - 2. Hastings Industries.
  - 3. Sterling HVAC Products; a Mestek company.
  - 4. Trane (Basis of Design)

## 2.2 SYSTEM DESCRIPTION

- A. Factory-assembled, prewired, self-contained unit consisting of cabinet, supply fan, controls, filters, and indirect-fired gas burner to be installed interior to the building.
- B. Electrical Components, Devices, and Accessories: Listed and labeled as defined in NFPA 70, by a qualified testing agency, and marked for intended location and application.

#### 2.3 AIR FILTERS

- A. Comply with NFPA 90A.
- B. Cleanable Filters: Cleanable metal mesh; 1 inch.
- C. Disposable Panel Filters: Factory-fabricated, flat-panel-type, disposable air filters; 1 inch.

#### 2.4 UNIT CONTROL PANEL

- A. Factory-wired, fuse-protected control transformer, connection for power supply and field-wired unit to remote control panel.
- B. Control Panel: Surface-mounted remote panel, with engraved plastic cover and the following lights and switches:
  - 1. On-off-auto fan switch.
  - 2. Heat-vent-off switch.
  - 3. Supply-fan operation indicating light.
  - 4. Heating operation indicating light.
  - 5. Thermostat.
  - 6. Dirty-filter indicating light operated by unit-mounted differential pressure switch.
  - 7. Safety-lockout indicating light.

#### **PART 3 - EXECUTION**

## 3.1 INSTALLATION

- A. Install gas-fired units according to NFPA 54, "National Fuel Gas Code."
- B. Install controls and equipment shipped by manufacturer for field installation with direct-fired heating and ventilating units.

#### 3.2 CONNECTIONS

- A. Drawings indicate general arrangement of piping, fittings, and specialties.
  - 1. Gas Piping: Comply with requirements in Section 231123 "Facility Natural-Gas Piping." Connect gas piping with shutoff valve and union, and with sufficient clearance for burner removal and service. Make final connections of gas piping to unit with corrugated, stainless-steel tubing flexible connectors complying with ANSI LC 1/CSA 6.26 equipment connections.
- B. Duct Connections: Connect supply ducts to indirect-fired heating and ventilating units with flexible duct connectors. Comply with requirements in Section 233300 "Air Duct Accessories" for flexible duct connectors.
- C. Ground equipment according to Section 260526 "Grounding and Bonding for Electrical Systems."

#### 3.3 FIELD QUALITY CONTROL

- A. Perform tests and inspections with the assistance of a factory-authorized service representative.
- B. Units will be considered defective if they do not pass tests and inspections.
- C. Prepare test and inspection reports.

#### 3.4 ADJUSTING

- A. Adjust initial temperature set points.
- B. Set field-adjustable switches and circuit-breaker trip ranges as indicated.

## 3.5 DEMONSTRATION

A. Engage a factory-authorized service representative to train Owner's maintenance personnel to adjust, operate, and maintain heating and ventilating units.

**END OF SECTION 237339** 

## SECTION 238239.19 –WALL AND CEILING UNIT HEATERS

#### PART 1 - GENERAL

#### 1.1 RELATED DOCUMENTS

A. Drawings and general provisions of the Contract, including General and Supplementary Conditions and Division 01 Specification Sections, apply to this Section.

#### 1.2 SUMMARY

A. Section includes wall and ceiling heaters with propeller fans and electric-resistance heating coils.

#### 1.3 ACTION SUBMITTALS

- A. Product Data: For each type of product.
  - 1. Include rated capacities, operating characteristics, furnished specialties, and accessories.

#### 1.4 CLOSEOUT SUBMITTALS

A. Operation and maintenance data.

#### **PART 2 - PRODUCTS**

#### 2.1 MANUFACTURERS

- A. Subject to compliance with requirements, provide product indicated on Drawings or comparable product by one of the following:
  - 1. Basis of Design: Markel Products Company; TPI Corporation
  - 2. Trane Inc.
  - 3. Berko; Marley Engineered Products.
  - 4. Chromalox, Inc.
  - 5. Indeeco.

#### 2.2 DESCRIPTION

- A. Assembly including chassis, electric heating coil, fan, motor, and controls. Comply with UL 2021.
- B. Electrical Components, Devices, and Accessories: Listed and labeled as defined in NFPA 70, by a qualified testing agency, and marked for intended location and application.

#### 2.3 CABINET

- A. Front Panel: Stamped-steel louver, with removable panels fastened with tamperproof fasteners.
- B. Finish: Baked enamel over baked-on primer with manufacturer's standard color selected by Architect, applied to factory-assembled and -tested wall and ceiling heaters before shipping.
- C. Surface-Mounted Cabinet Enclosure: Steel with finish to match cabinet.

## 2.4 COIL

A. Electric-Resistance Heating Coil: Nickel-chromium heating wire, free from expansion noise and 60-Hz hum, embedded in magnesium oxide refractory and sealed in corrosion-resistant metallic sheath. Terminate elements in stainless-steel, machine-staked terminals secured with stainless-steel hardware, and limit controls for high-temperature protection.

#### 2.5 FAN AND MOTOR

A. Fan: Aluminum propeller directly connected to motor.

# NSA ARCHITECTS, ENGINEERS, PLANNERS Project No. 215062.00

#### CITY OF DEARBORN Ford Field Comfort Station

B. Motor: Permanently lubricated. Comply with requirements in Section 230513 "Common Motor Requirements for HVAC Equipment."

## 2.6 CONTROLS


- A. Controls: Built-in Thermostat.
- B. Electrical Connection: Factory wire motors and controls for a single field connection with disconnect switch.

## **PART 3 - EXECUTION**

#### 3.1 INSTALLATION

- A. Install wall and ceiling unit heaters to comply with NFPA 90A.
- B. Install wall and ceiling unit heaters level.
- C. Ground equipment according to Section 260526 "Grounding and Bonding for Electrical Systems."
- D. Connect wiring according to Section 260519 "Low-Voltage Electrical Power Conductors and Cables."

**END OF SECTION 238239.19** 

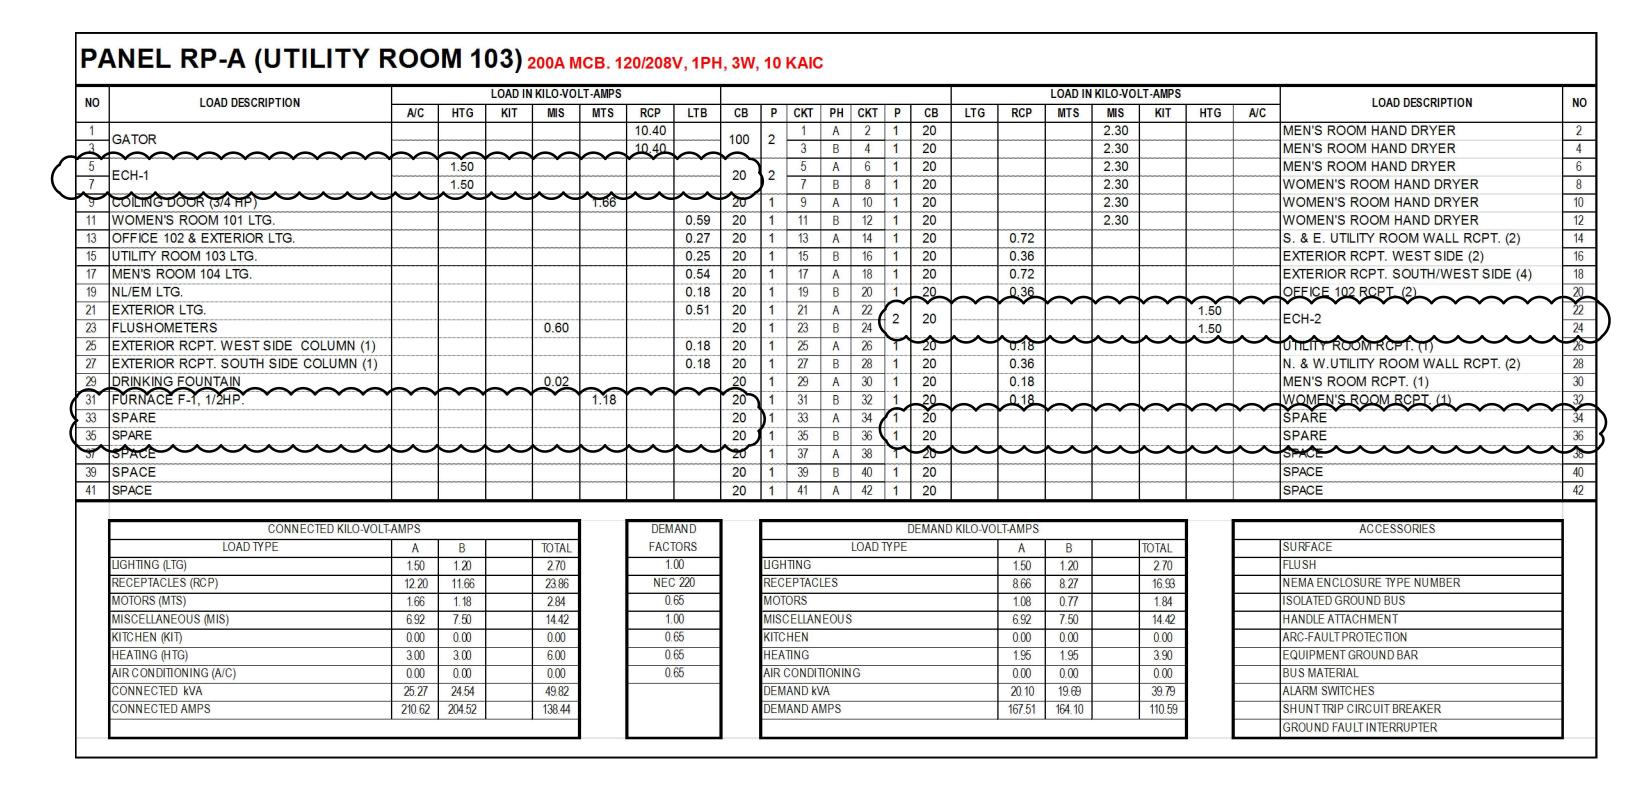


## **GENERAL NOTES**

- 1. ALL WIRING IN CONDUITS SHALL RUN CONCEALED UNLESS OTHERWISE NOTED.
- 2. ALL EQUIPMENT SHALL BE INSTALLED IN A NEAT AND WORKMANLIKE MANNER, RECTILINEAR TO BUILDING STRUCTURE.
- 3. CONSTRUCTION DOCUMENTS CONSIST OF PLANS, DETAILS, DIAGRAMS, AND
- 4. ALL RACEWAYS AND CABLE TRAYS (IF ANY) RUNNING ACROSS BUILDING EXPANSION JOINTS SHALL BE EQUIPPED WITH EXPANSION FITTINGS.
- 5. ELECTRICAL SERVICES (HOME RUNS) SHOWN ON THE DRAWINGS ARE SHOWN DIAGRAMMATICALLY, CONTRACTOR SHALL VERIFY ROUTING AND MEET CONDUCTOR FILL/AMAPACITY REQUIREMENTS PER THE NATIONAL ELECTRICAL CODE.
- CONTRACTOR SHALL REVIEW CONTRACT DOCUMENTS OF ALL TRADES TO DETERMINE SPECIFIC MOUNTING LOCATIONS FOR ELECTRICAL EQUIPMENT, COORDINATE EXACT
- 7. REFER TO ARCHITECTURAL PLANS AND ELEVATIONS FOR MOUNTING HEIGHTS AND LOCATION OF ALL DEVICES UNLESS SHOWN ON ELECTRICAL DRAWINGS.
- 8. PROVIDE ALL REQUIRED SUPPORTS AND MATERIALS TO INSTALL ELECTRICAL DEVICES AND EQUIPMENT, COORDINATE WITH MANUFACTURES SUBMITTALS.
- 9. ALL ELECTRICAL WIRING FROM THE SERVICE ENTRANCE TO DOWNSTREAM DEVICES SHALL BE COPPER (CU) UNLESS OTHERWISE NOTED ON PLANS.
- 10. LIGHTING/RECEPTACLE BRANCH CIRCUITS 100 FEET AND FURTHER FROM THEIR ASSOCIATED PANELS SHALL BE FED WITH #10 WIRING MINIMUM. UNLESS OTHERWISE NOTED.
- 11. PROVIDE LABELING OF CIRCUIT NUMBERS ALL RECEPTACLES.

LOCATION WITH THE ARCHITECTURAL DRAWINGS.

12. ELECTRICAL CONTRACTOR TO VERIFY EXACT SERVICE VOLTAGE (208V. VS. 240V.)
WITH UTILITY COMPANY AND COORDINATE EQUIPMENT VOLTAGE REQUIREMENTS WITH
MECHANICAL TRADES.

	LUMINAIRE SCHEDULE											
TYPE	MANUFACTURER	CATALOG NUMBER	LAMP	VOLTS	MOUNTING	DESCRIPTION						
LA	JUNO	L6-50401-G3-L600P- CS-WET	LED 45.3W.	120	RECESS	6" DIAMETER RECESSED LED DOWNLIGHT, IC RATED.						
LAE	JUNO	L6-50401-G3-BR L600P-CS-WET	LED 45.3W.	120	RECESS	6" DIAMETER RECESSED LED DOWNLIGHT WITH EMERGENCY BATTERY BACK-UP, IC RATED.						
LB	LITHONIA	LED Z SERIES ZL2NL48-3000LM-MDD- 35K-80CRI-WH	LED 42W.	MVOLT	SURFACE/ CHAIN HUNG	4' LONG SURFACE CEILING/CHAIN HUNG LED LENSED STRIPLIGHT FIXTURE.						
LC	SOLERA	SMRT-24LED-120-OPL -TP-SG	LED 29W.	120	SURFACE	9 1/2" DIAMETER SURFACE MOUNTED LED LAMP						
ЕМ	LITHONIA	ELM2-LED-HO	6W	MVOLT	CEILING	EMERGENCY LIGHT FIXTURE WITH BATTERY PACK FOR 90 MINUTES						

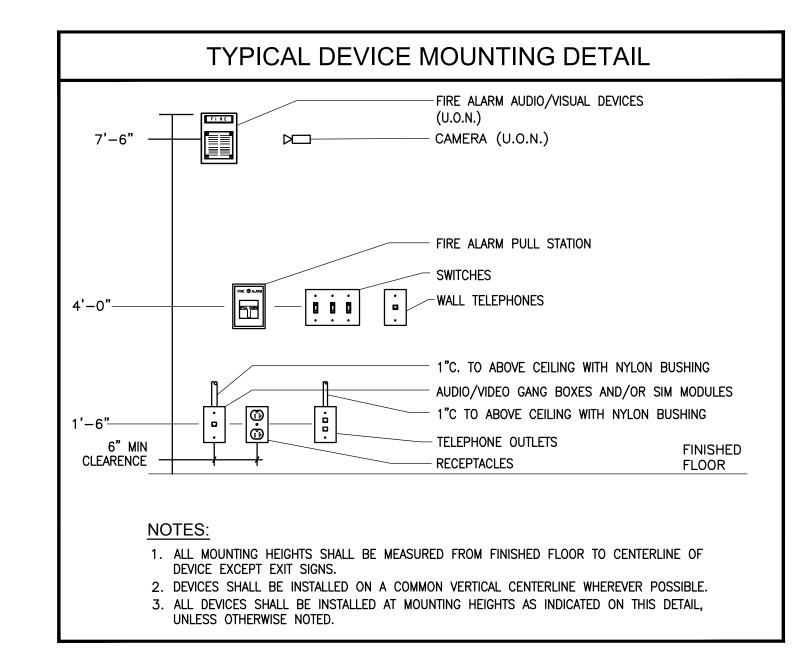

SYMBOL	DESCRIPTION
Ф	DUPLEX RECEPTACLE NEMA 5-20R-125V, WHEN NOTED "D" DEDICATED
<b>#</b>	DOUBLE DUPLEX RECEPTACLE NEMA 5-20R-125V
<b>•</b>	NEMA RECEPTACLE 30A, 50A, 250V. "TL" TWIST LOCK. (NEMA 6-30R, 6-50R)
$\bigcirc$	JUNCTION BOX
	NON-FUSED DISCONNECT SWITCH
<b>\(\)</b>	SINGLE PHASE, THREE PHASE MOTOR
	ELECTRICAL PANELS (RECESSED , SURFACE MOUNTED @ 6'-6" A.F.F. TO TOP)
•	ELEC SERVICE CONNECTION (SINGLE POINT) AT EQPT. DISCONNECT DEVICE BY EQP
$\bigcirc$	UTILITY METER
0 04	CEILING OR WALL MOUNTED FIXTURE
$ \leftarrow $	WALL MOUNTED 84" MIN. A.F.F. BATTERY POWERED EMERGENCY BACKUP LIGHT FIXT
$\vdash$	CEILING OR WALL MTD FLUORESCENT FIXTURE, SEE FIXTURE SCHED.
S	SINGLE POLE TOGGLE SWITCH
Sĸ	KEY OPERATED SWITCH
PC	PHOTOCELL

Α	AMPERES	KVA	KILOVOLT AMPERES
ADA	AMERICANS WITH DISABILITIES ACT	KW	
AFF	ABOVE FINISH FLOOR	LTG	LIGHTING
AIC	AMPERE INTERRUPTING CAPACITY	MCB MDP	MAIN CIRCUIT BREAKER
AL	ALUMINUM	MDP	MAIN DISTRIBUTION PANEL/SECTION
ARCH	ARCHITECT	MECH	MECHANICAL
ATS	AUTOMATIC TRANSFER SWITCH	MSB	MAIN SWITCHBOARD
AWG	AMERICAN WIRE GAUGE	MISC	MISCELLANEOUS
CB	CIRCUIT BREAKER	MLO	MAIN LUGS ONLY
CKT/CIRC	CIRCUIT	NTS	NOT TO SCALE
COĽ	COLUMN	NIC	NOT IN CONTRACT
CT	CURRENT TRANSFORMER	PB	PUSHBUTTON
CU	COPPER	PC	PERSONAL COMPUTER
DWG	DRAWING	PNL	PANELBOARD
EF	EXHAUST FAN	PNL PP	POWER PANEL
ELEC	ELECTRICAL	PVC	POLYVINYL CHLORIDE
EM	EMERGENCY	PWR	POWER
EMT	ELECTRICAL METALLIC TUBING	REQ'D	REQUIRED
EP0	EMERGENCY POWER-OFF	SP	SPARE
EPO EWC	ELECTRIC WATER COOLER	TVSS	TRANSIENT VOLTAGE SURGE
FAAP	FIRE ALARM ANNUNCIATOR PANEL		SUPPRESSION
FACP	FIRE ALARM CONTROL PANEL	UG	UNDERGROUND
FLA	FULL LOAD AMPS	UC UON	UNDER COUNTER
FMCS	FACILITY MANAGEMENT CONTROL	UON	UNLESS OTHERWISE NOTED
	SYSTEM	UH	UNIT HEATER
GRD	GROUND	V	VOLT
GFCI	GROUND FAULT CIRCUIT INTERRUPTER	VA	VOLT AMPERES
HOA	HAND-OFF-AUTOMATIC SWITCH	VIF	VERIFY IN FIELD
ICMS	INTEGRATED CARE MANAGEMENT SYSTEM	/ WH	WATER HEATER
	HAND-OFF-AUTOMATIC SWITCH INTEGRATED CARE MANAGEMENT SYSTEM	WP	WEATHERPROOF
		YEMP	TRANSFORMER



CITY OF DEARBORN

DEARBORN MICHIGAN

Project Title:
FORD FIELD
COMFORT STATION

 Date:
 Issued for:

 04-25-2016
 BIDS & PERMITS

 04-03-2017
 ADDENDUM NO.3

Drawn: KG Designed: JC

Checked: JC Approved: JC

CAD Drawing File:
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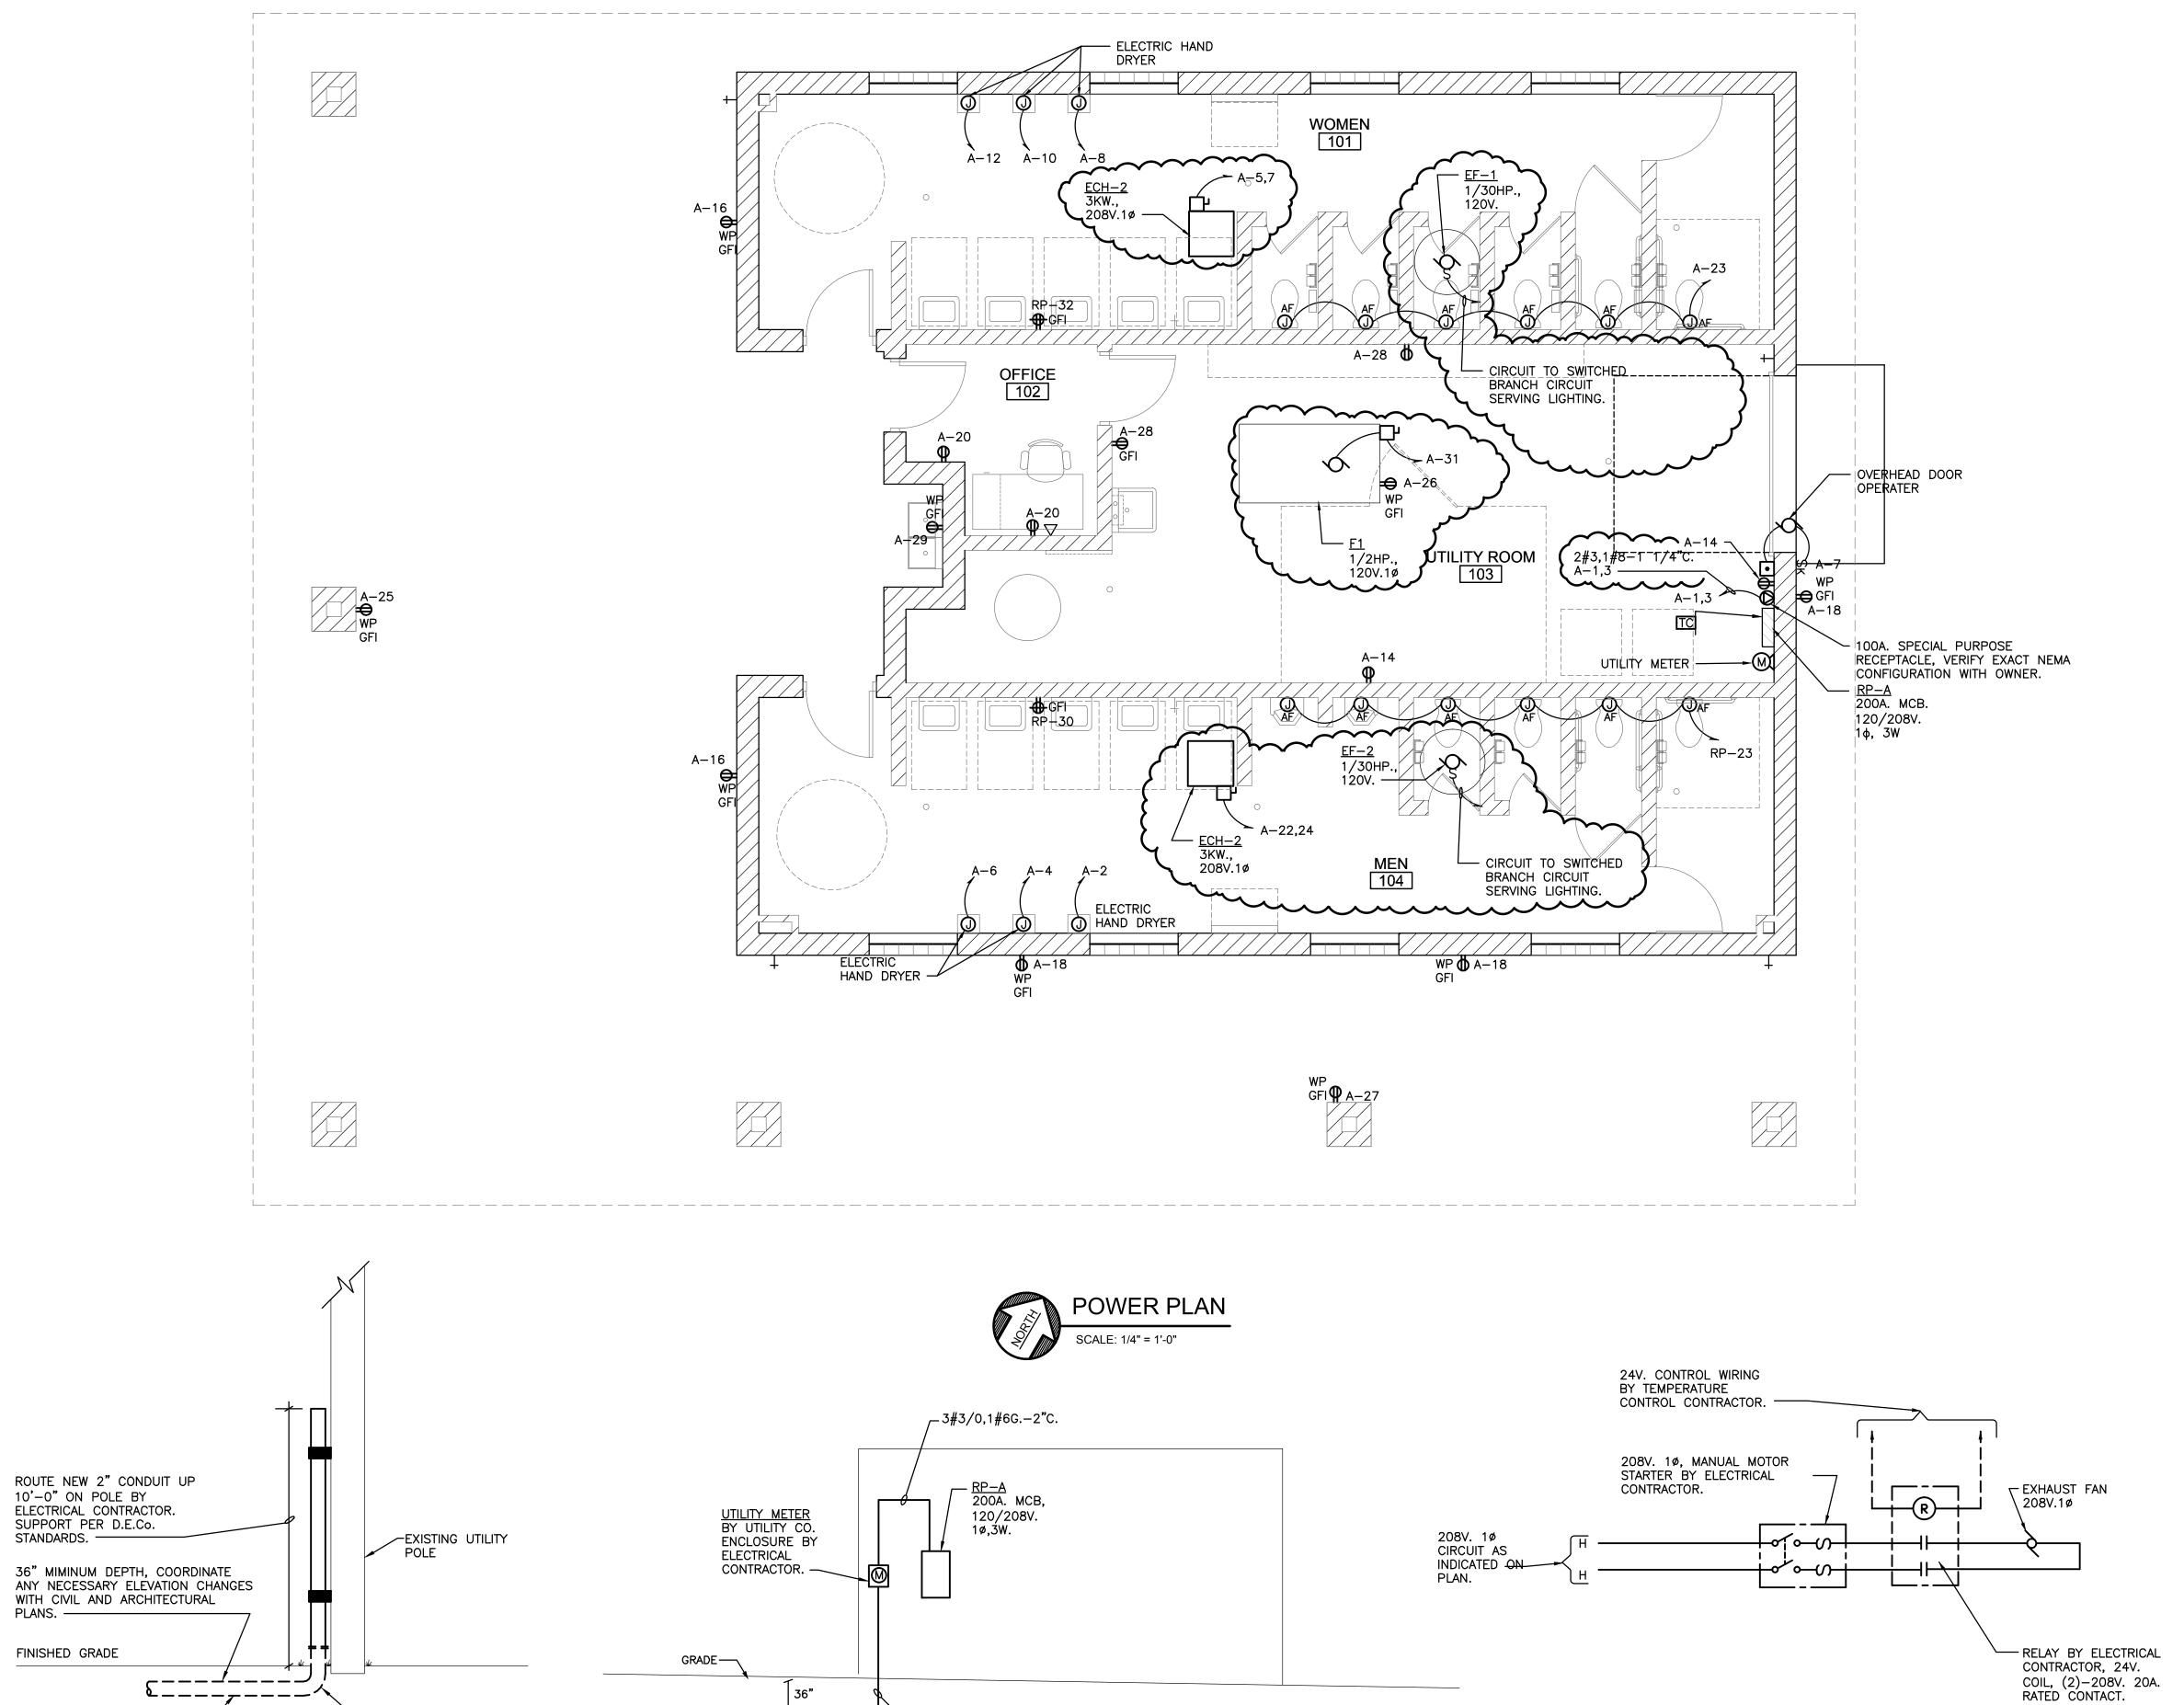
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Project Number: 215062.00

Sheet Title:
ELECTRICAL
SYMBOLS, LEGENDS,
LUMINAIRE SCH. &
NOTES

Sheet Number:

E1.0



2"C. (EMPTY) TO UTILITY
POLE BY ELECTRICAL
CONTRACTOR. PROVIDE
PULLSTRING.

ELECTRICAL POWER RISER DIAGRAM

¢----

NOT TO SCALE

UTILITY POLE DETAIL

2" CONDUIT STUBBED
UP TO POLE. ————

-2" G.R.S. LONG SWEEP ELL.

23761 Research Drive Farmington Hills Michigan 48335

248.477.2444 248.477.2445 fax www.nsa-ae.com Founded 1960

CITY OF DEARBORN

MICHIGAN

DEARBORN

Project Title: FORD FIELD **COMFORT STATION** 

Issued for: BIDS & PERMITS 04-25-2016 03-22-2017 ADDENDUM NO.1 04-03-2017 ADDENDUM NO.3

Checked:

CAD Drawing File: Copyright © 2014 NSA Architects, Engineers. Planners

Project Number: 215062.00

Sheet Title:

**EXHAUST FAN** 

NO SCALE

CONTROL WIRING DIAGRAM

**POWER PLAN** 

Sheet Number:

E3.0

	GRILLE, REGISTER AND DIFFUSER SCHEDULE												
TAG	BASIS OF DESIGN TYPE CFM RANGE NECK SIZE SURFACE MODULE MAX NC 1												
S-1	TITUS, TDC	SUPPLY	0-160	6"	12x12	30	1						
S-2	TITUS, TDC	SUPPLY	0-160	6"	24X24	30	1						
S-3	TITUS, TDC	SUPPLY	300-500	10"	24X24	30	1						
E-1	TITUS, 350R	EXHAUST	50-350	10"x10"	12"X12"	30	1						
R-1	TITUS, PAR	RETURN	500-700	12"x12"	24"X24"	30	1						
R-2	TITUS, PAR	RETURN	100-300	8"x8"	12"X12"	30	1						
NOTES:		-	_										

1) OPPOSED BLADE VOLUME DAMPER, WHITE FINISH


FAN SCHEDULE												
	MOTOR DATA											
TAG	BASIS OF DESIGN	LOCATION	SERVICE	TYPE	CFM	E.S.P.	DRIVE	HP	VOLTS	PHASE	Hz	COMMENTS
EF-1/EF-2	GREENHECK G-080 G	ROOF	FACILITY	CENTRIFUGAL	300	0.25	DIRECT	1/30	120	1	60	1,2,3
NOTES:												
1) PROVIDE	DISCONNECT SWITCH, BACK-DRAF	T DAMPER, AND BIRDSCREE	ĒN.									
2) PROVIDE	2) PROVIDE ROOF CURB.											
3) INTERLO	S) INTERLOCK WITH LIGHT SWITCH											


	L
	Α
	Е
COMMENTS	P
1,2,3	•
	2376
	Farr
	Micl

	FURNACE SCHEDULE											
TAC	LOCATION	BASIS O	F DESIGN	E O D OFM		HEATING	HEATING SECTION		ELECTRICAL			
TAG	LOCATION	MANUFACTURER	MODEL	E.S.P.	CFM -	INPUT (MBH)	OUTPUT (MBH)	VOLTS / PH / HZ	HP	NOTES/ACCESSORIES		
F-1	UTILITY ROOM	TRANE	TUH1B080A9H31A	0.50	1200	80	76	120/1/60	1/2	1,2		
NOTES:												
1) UNIT TO BE MOUNTED BETWEEN TRUSSES, SUPPORTED BY SPRING/ISOLATION MOUNTS AT FOUR CORNERS.												
2) PROVIDE DISCONNECT SWITCH, DIGITAL TEMPERATURE ROOM SENSOR												

	INTAKE HOOD											
TAG	BASIS OF DESIGN	MODEL	TYPE	CFM RANGE	SIZE	THROAT DIA	NOTES					
IH-1	GREENHECK	GRSF-10	INTAKE	450	20"	10"	1					
NOTES:	NOTES:											
1) PROVIDI	1) PROVIDE INSECT/BIRD SCREEN, AND BACK-DRAFT DAMPER.											

ELECTRIC CEILING HEATER SCHEDULE									
ELECTRICAL									
TAG	BASIS OF DESIGN	LOCATION	HEATING CAPACITY	VOLTS/PHASE	COMMENTS				
ECH-1/ECH-2	MARKEL F3485A1	TOILET RM	5 KW	208/1	1,2				
NOTE 1: INTEGRAL BUILT IN ADJUSTABLE THERMOSTAT, DISCONNECT SWITCH									
NOTE 2: RECESS MO	UNTED CEILING HEATER								

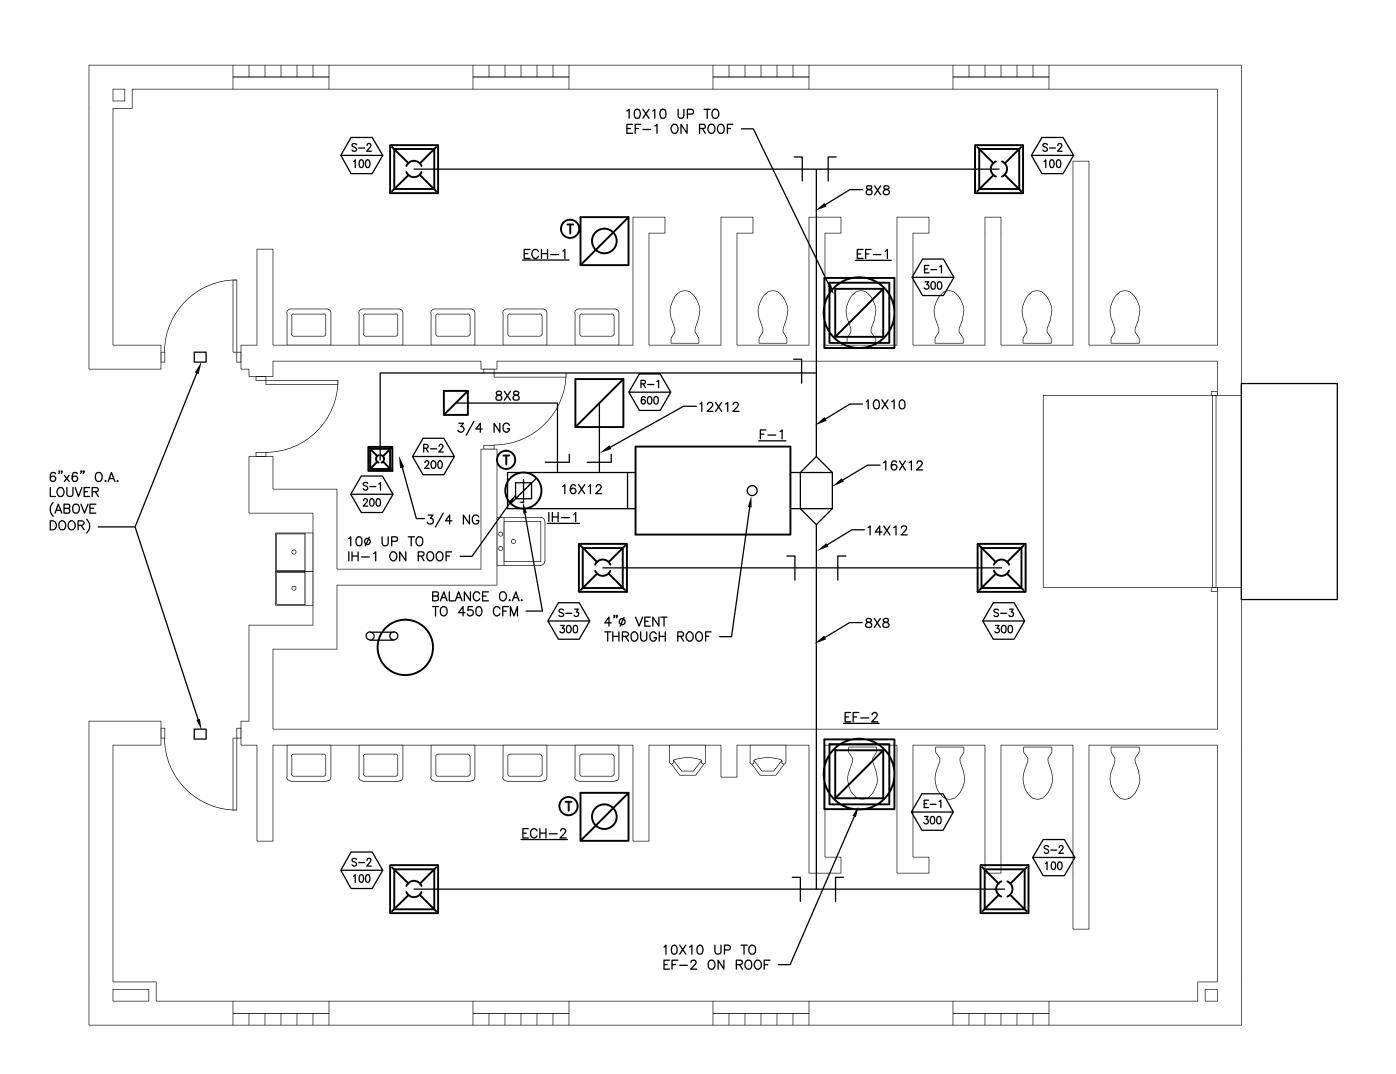

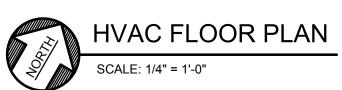

## **GENERAL NOTES**

- PRIOR TO PURCHASE OF ANY MECHANICAL EQUIPMENT, MECHANICAL CONTRACTOR TO VERIFY EXACT SERVICE VOLTAGE (208V. VS. 240V.) WITH ELECTRICAL CONTRACTOR.
- RUN SUPPLY/EXHAUST/RETURN DUCTWORK ABOVE CEILING. PROVIDE INSULATION IN UNCONDITIONED SPACE.
- MOUNT F-1 FLUSH TO BOTTOM CHORD OF TRUSS. COORDINATE WITH STRUCTURAL.

1								
A	r	c	h	ì	t	e c	t	s
E	n	g	ì	n	e	е	r	s
P	I	а	. 1	n	n	e	r	s

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CITY OF DEARBORN

MICHIGAN

DEARBORN

Project Title:
FORD FIELD COMFORT STATION

Issued for: Date: OWNER REVIEW 03-18-2016 04-25-2016 BIDS & PERMITS 04-03-2017 ADDENDUM NO. 3

Checked: Approved: CAD Drawing File:

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Sheet Title: **HVAC PLAN** 

Sheet Number:

M1.0

LAVATORY

SINK)

COOLER

HOSE BIBB

(MOP

2018HBNS

FIAT

ELKAY

VRCTLDDWS

NEPTUNE

ZURN

WILKINS 375

WOODFORD

MODEL 65

LAV-1/

LAV-1 1½"HW ┛/

- ½"CW, SLOPE TO HOSE BIBB FOR DRAINAGE, ROUTED ABOVE CEILING TIGHT TO DRYWALL.

LAV-1

½"CW, SLOPE TO HOSE BIBB

FOR DRAINAGE, ROUTED ABOVE CEILING TIGHT TO DRYWALL.

1-1/2"

1-1/2"

1-1/2"

1/2"

1/2"

1-1/2"

1-1/2"

FIELD VERIFY EXACT LOCATION OF EXISTING GAS.

1½"NG -

SEE NOTE 4

SEE NOTE 4

WATER METER/ BACKFLOW

PREVENTER ASSEMBLY -

-SEE NOTE 4

TO DRAIN

TO DRAIN

PIPE CHASE/COVER

DIAGRAM

20"

" UNDERGROUND NG

GAS METER/PRV

LOAD - 200 CFH, 0.5 PSI, LONGEST RUN

1/2"

1/2"

1-1/2"

1/2"

PLUMBING FIXTURE SCHEDULE

LEVER FAUCET WITH AERATOR, AMERICAN STANDARD COLONY SOFT 2275.500. ADA COMPLIANT. PROVIDE R19 VALVE STOPS WITH REMOVABLE BONNET, PERFORATED DRAIN STRAINER AND TRAP ASSEMBLY WITH PROTECTIVE PIPE COVERS EQUAL TO TRUEBRO 102. FAUCET TO BE CHROME FINISH, WITH RENEWABLE SEATS AND DISKS OR CARTRIDGE STYLE.

MUSTEE MODEL 63M, 24"X24"X10" DEEP, ONE-PIECE MOLDED DURASTONE STRUCTURAL FIBERGLASS, 3" PVC SCH.80 DRAIN SEAL INTGRALLY MOLDED, STAINLESS STEEL STRAINER, HOSE AND BRACKET (65.7), MOP HANGER (65.6). FAUCET: ZURN, MODEL Z843M1-RC, ROUGH CHROME PLATED WITH VACUUM BREAKER, 1/4 TURN CERAMIC DISC CARTRIDGES, INTEGRAL SERVICE STOPS WITH ADJUSTABLE CENTERS, 3/4" HOSE THREADED OUTLET, PAIL HOOK AND ADJUSTABLE WALL BRACE.

ADA, ELECTRIC WATER COOLER, STAINLESS STEEL CONSTRUCTION, INCLUDE VANDAL-RESISTANT BUBBLER, BOTTLE FILLING UNIT SHALL INCLUDE AN AUTOMATIC 20-SECOND SHUT-OFF TIMER, QUICK FILL RATE 1.5 GPM, LAMINAR FLOW, VANDAL-RESISTANT PUSHBUTTON ACTIVATION, REAL DRAIN SYSTEM. PROVIDE 1/4 TURN SHUT-OFF VALVE.

CONSTRUCTED OF LEAD FREE RILSAN NYLON-COATED DUCTILE IRON WHICH IS CHEMICAL AND CORROSION RESISTANT. RATED AT 150 PSI WORKING PRESSURE. STAINLESS STEEL STRAINER PLATE AND COVER BOLTS. INLINE SERVICEABILITY. PREVENTION OF DEBRI SUCH AS STONES OR PEBBLES GREATER THAN 3/16" IN DIAMETER FROM ENTERING OR DAMAGING WATER METER.

REDUCED PRESSURE PRINCIPAL ASSEMBLY, ASSE LISTED 1013 AND IAMPO LISTED. REINFORCED NYLON HOUSING, SUPPLIED WITH CAST BRONZE BALL VALVES AND SILICONE SEAT DISC ELASTOMERS . 2" SIZE WITH A MAXIMUM WORKING WATER PRESSURE = 175 PSI, RATED TO 180 DEG. F MAXIMUM WORKING TEMPERATURE.

HOSE BIBB, SINGLE CHECK ANTI-SIPHON BACKFLOW PROTECTION, FREEZLESS, WITH 3/4" THREADED HOSE NOZZLE AND TEE KEY OPERATION.

2"CW -

SEE NOTE 4 -

2"CW

- SEE NOTE 8 SEE NOTE 4


MIXING VALVE SEE 2/P1.0

DOMESTIC HOT WATER HEATER SCHEDULE GAS DATA HEATING CAPACITY ELECTRICAL **CAPACITY** TAG BASIS OF DESIGN LOCATION GAL. TYPE | INPUT CFH RECOVERY GPH | TEMP RISE VOLTS/PHASE | COMMENTS WH-1 A.O. SMITH CYCLONE BTH-120A MXI UTILITY RM 60 N. GAS 120 1,2,3,4 157 88 120/1

1) PROVIDE P&T RELIEF VALVE TO FLOOR DRAIN. SET HEATER AT 140°F 2) PROVIDE SYSTEM LAWLER #802 MIXING VALVE WITH 1" HW AND CW INLETS, AND 1 1/4" OUTLET.

3) PROVIDE GAS PRESSURE REGULATOR FOR 1 PSI GAS MAIN PRESSURE

4) LOW WATER CUTOFF AND CONDENSATE NEUTRALIZATION KIT.

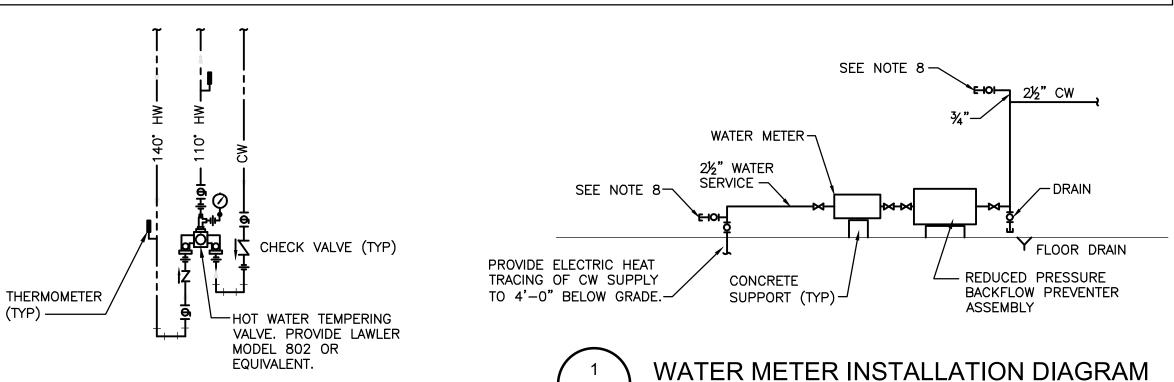

P1.0

P1.0

WC-1

2"V 2"CW \_/

WC-1

HB-1 -

2"CW -

WC-1

- 3" VENT UP TO 4"

VENT THRU ROOF

WATER MIXING VALVE DIAGRAM NO SCALE

**GENERAL NOTES:** 

1. THE CONTRACTOR SHALL PROVIDE R19 VALVE STOPS WITH REMOVAL BONNETS AS REQUIRED BY OWNER FOR DRAINING.

2. ALL PLUMBING TO BE INSTALLED AND SLOPED FOR GRAVITY DRAINAGE AND SEASONAL SHUTDOWN.

3. PROVIDE HANGERS FOR ALL PIPING.

COVER/CHASE MOUNTED AT 26" AFF TO TOP.

5. PROVIDE A MANUAL MAIN GAS SHUT-OFF VALVE.

6. PROVIDE ACCESS PANELS FOR VALVES LOCATED ABOVE CEILING.

7. ROUTE VENTING IN WALLS AND ABOVE CEILING.

8. PROVIDE THREADED PIPE CONNECTION AND CAP, FOR CONNECTION OF COMPRESSED AIR SUPPLY FOR WINTERIZING OF SYSTEM.

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MICHIGAN

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**□** FD-1 ✓ 4"SAN - 4"SAN 4"SAN - 3"SAN 4"SAN ─ 4"SAN 1½"SAN -4"SAN FD-1 - 4"SAN 3"SAN -3"SAN -4"SAN 4"SAN -- 4"SAN

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Sheet Title:

**PLAN** 

PLUMBING PLAN FLOOR PLAN - ABOVE GROUND SCALE: 1/4" = 1'-0"



Sheet Number: P1.0

PLUMBING FLOOR

215062.00